MULTIMODAL ACCESS CLOSURE EXCEPTION APPLICATION FORM AND CHECKLIST

Submittal Date: 3-13-24	□-New Submittal □ Re-Submittal No:
Related Building Permit No: 2023	001100
Project Name: CHASE BANK	
Street Name Location: 2825 Wes	TEND AVE.
Between: Z9TH AVE S	And: Zath Ave N
Applicant Name: 115 ENGINGER.	NG : UTILITIES
Address: 119 PARK SOUTH C	
Phone: 615-515-21680 Fax: 615-	515-468 Contact: ILKE HANGSER
Email: ILKEH@ISENGINEERING	.026
Project Description: The TALL PL	BUC SANTARY SOWER
MAIN EXTENSION	
	20/24 Project Length: 31 DAYS
Describe Type of Closure:	R CLOSURE- PEDESTRIANS
To Bo DeToured INTO	
Provide Reasons why Project cannot be co	
	ts as needed): Sowor Main
	C I THE SIDEWALK
No OTHER OPTION FOR	Sewer LOCATION

PROJECT INFORMATION CHECKLIST:


Included Not Applicable

0		Project Vicinity Map with Project Area shown, street names, property information, existing pavement and striping, gutter and building locations, north arrow, and scale.
4		Planned work hours included. NIGHT - TOP - GAM BUN-THURS
		Exact location and dimensions of the construction work zone shown.
	3	If multiple phases are necessary, include perimeter impact of each phase, phase number, anticipated work hours and phase duration.
		Details on construction activity and equipment being used as part of construction included for each phase.
		Specify if any on-street parking, and/or metered parking, is to be restricted and if bus zone will need to be relocated.
		Specify if trash pickup will be impacted.
9		Provide information on all utility work and utility connections. Translation
		List all affected residents, businesses, agencies, and schools and any conversations/agreements taken place.
		Show ongoing construction projects within vicinity of proposed project impact.
		Provide plan to address conflicts with other nearby projects.
		Provide traffic control plan for each phase of construction (see traffic control checklist for more information).
9		Provide information on work vehicle parking locations.
		Show construction trucks ingress/egress to project location.
9		Provide information on any traffic signals, traffic signal loops, and traffic signal cabinets in close proximity to project.


TRAFFIC CONTROL PLAN CHECKLIST:

Included Not Applicable

	All temporary traffic control plans shall be designed in accordance with the most recent ADA regulations and requirements of the Manual of Uniform Traffic Control Devices.
	Clearly show the locations of all existing signs (including speed limit) as well as the proposed signs for each construction phase.
	Show the location of all existing pedestrian paths and pedestrian detour route of each stage of construction.
	Show dimensions of travel lane width, shoulder width, sidewalk of each phase, and overall roadway width along the length of affected area.
	Show all existing striping and markings to remain, to be removed, and all proposed striping and markings for each construction stage.
	Provide detour plan clearly showing detour route for any roadway or pedestrian/bike path closures.
C	Specify placement of all temporary traffic control devices.
9	Specify spacing of all temporary traffic control devices.
	Show all existing traffic signals and streetlights in the work zone location.
9	Lighting provided for all pedestrian detour routes.
9	Provide minimum eleven (11) foot travel lanes at all times.
	Show size, height, and location of all channelizing devices, warning lights, flag trees, barriers, etc.
1	Label all taper lengths and widths.
î	Provide locations of police officers for each phase as needed.
	Temporary Traffic Control Plan has been stamped and signed by a TN licensed Civil Engineer.

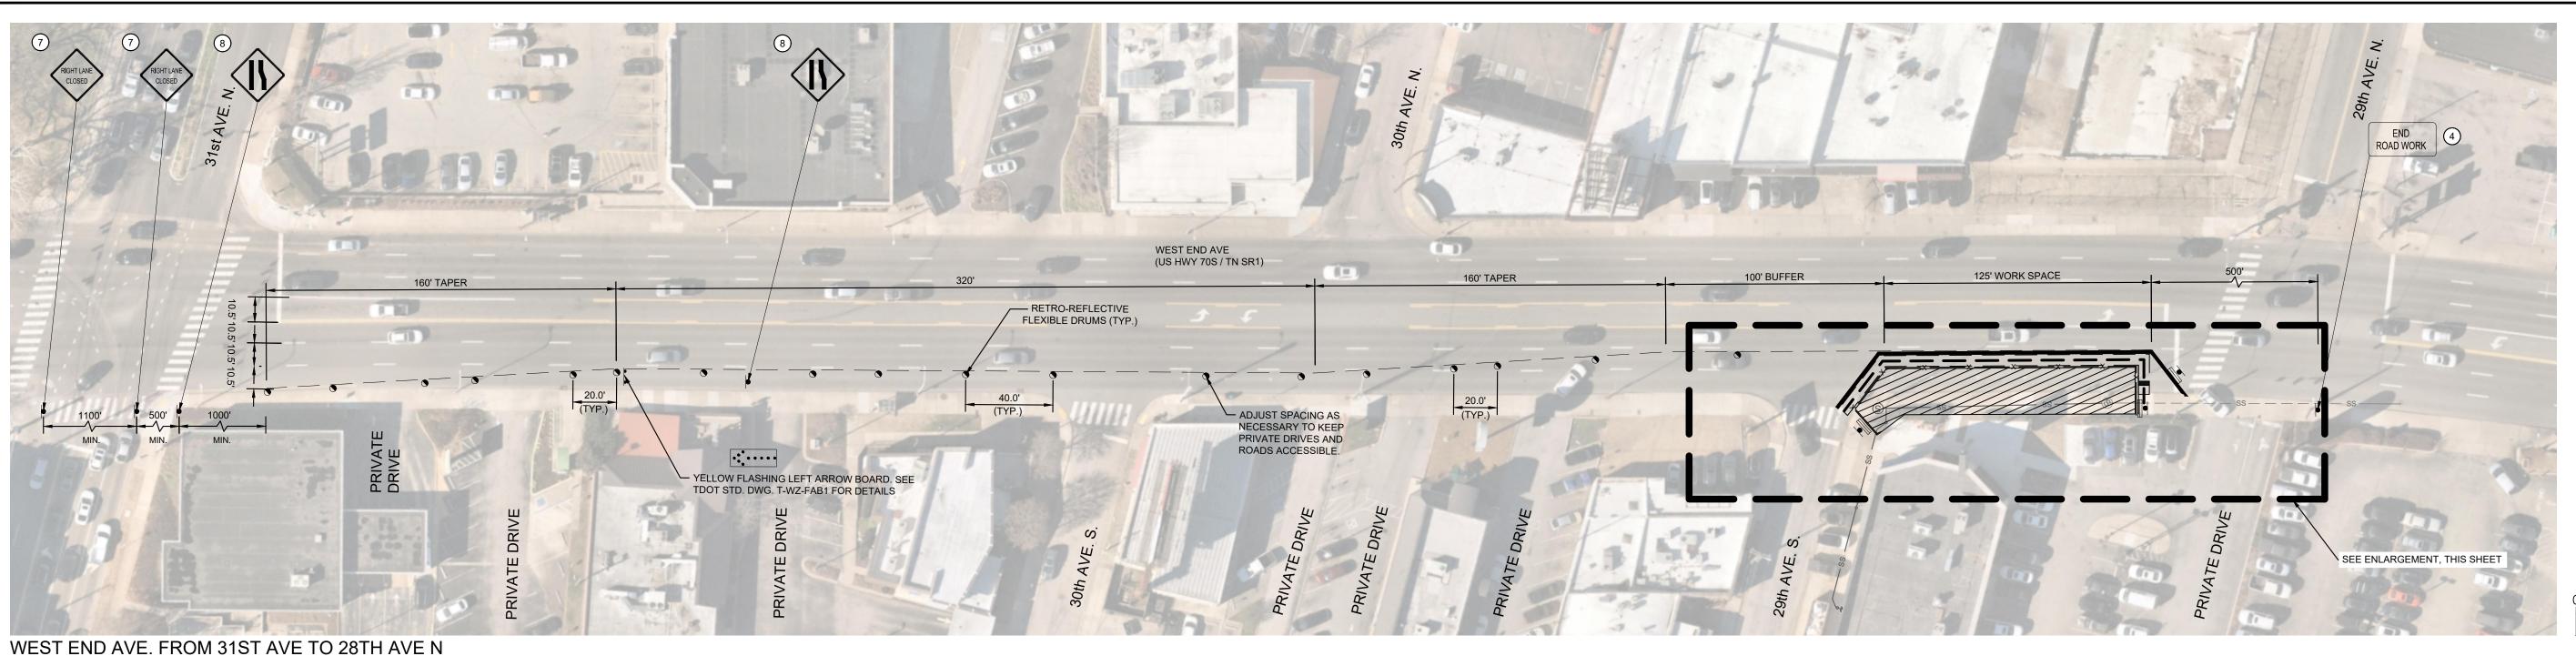





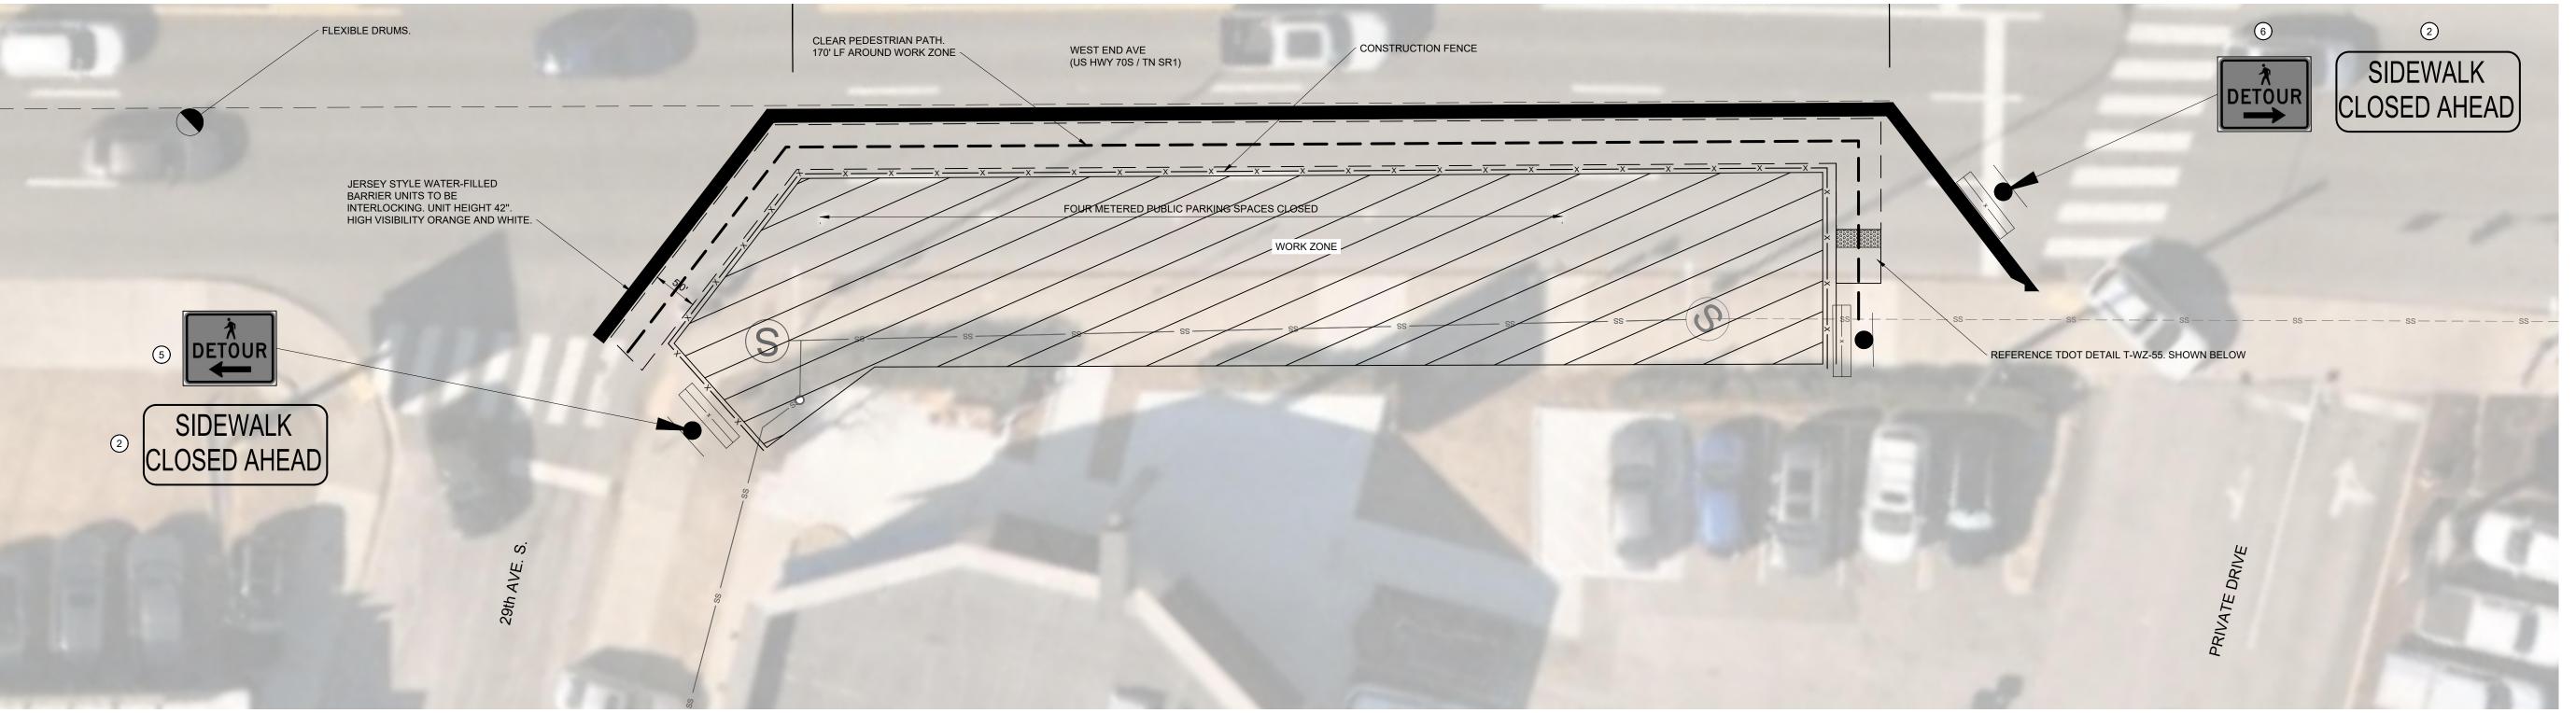

GRAPHIC SCALE IN FEET

PEDESTRIAN DIVERSION AT WORK ZONE

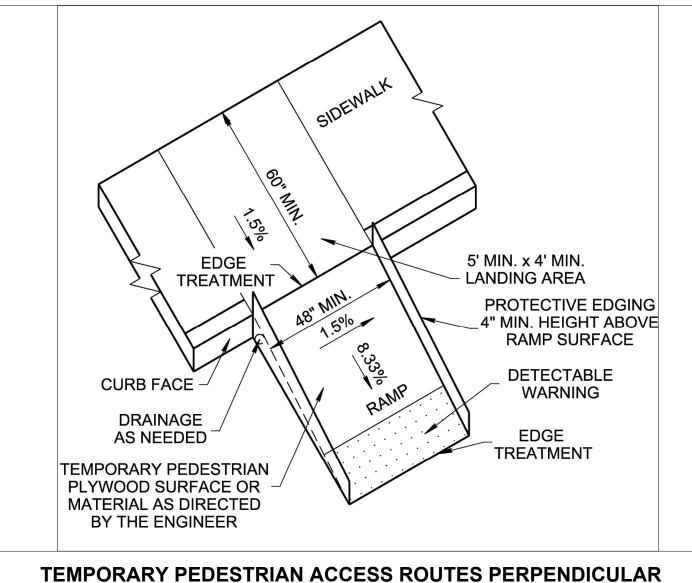

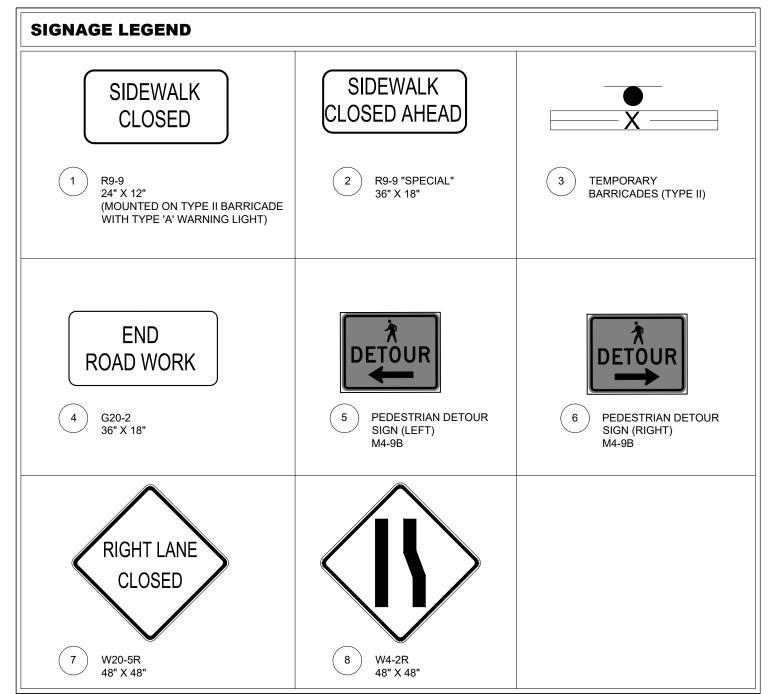

NDOT NOTES


- I. FOUR METERED PARKING SPACES AT 2829 WEST END AVE. WILL BE CLOSED FOR THE DURATION OF THIS WORK.
- . THE PHASE NOTED AS "DAY" IS REQUIRED FROM 7:00 A.M. TO 6:00 P.M. 3. THE TRANSITION TO THE "DAY" CONFIGURATION MUST BE COMPLETED
- 4. THE PHASES AS "NIGHT" IS ALLOWED FROM 7:00 P.M. TO 6:00 A.M.
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- 6. NIGHT CONFIGURATION WILL HAVE TWO UNIFORMED POLICE OFFICERS POSTED TO DIRECT TRAFFIC.

SIDEWALK DIVERSION NOTES

- . THE PEDESTRIAN WALKWAY SHALL BE AT LEAST 5' WIDE. 2. TEMPORARY FACILITIES SHALL BE COMPLIANT WITH THE CURRENT VERSION OF THE AMERICANS WITH DISABILITIES ACT ACCESSIBILITY
- GUIDELINES (ADAAG). 3. DIVERSIONS MUST BE CLEARLY IDENTIFIED, PROTECTED FROM
- TRAFFIC AND FREE FROM HAZARDS. PEDESTRIANS CONSTRUCTION BARRIER FENCE SHALL BE
- CONTINUOUS THROUGHOUT THE LENGTH OF THE DIVERSION WITH A DETECTABLE EDGING WITH A BOTTOM NO HIGHER THAN 2" ABOVE THE SURFACE AND A TOP NO LOWER THAN 32" ABOVE THE SURFACE, THE PEDESTRIAN CHANNELIZATION DEVICE SHALL BE ORANGE. HIGH VISIBILITY FENCE, PEDESTRIAN. RAIL AND CHAIN LINK FENCE ARE
- CROSSING THE DIVERSION PATH BY CONSTRUCTION VEHICLES SHOULD BE AVOIDED, WHEN NECESSARY IT SHALL BE CONTROLLED BY
- 6. A SMOOTH, HARD, CONTINUOUS AND RIDEABLE SURFACE SHALL BE
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MAINTENANCE OF TRAFFIC GENERAL NOTES

- TRAFFIC CONTROL SHALL COMPLY WITH THE LATEST VERSION OF THE MANUAL OF UNIFORM TRAFFIC CONTROL DEVICES (MUTCD), THIS MAINTENANCE OF TRAFFIC PLAN, AND/OR AS DIRECTED BY NDOT. CONSTRUCTION WORK HOURS SHALL BE IN ACCORDANCE WITH THE METRO NASHVILLE CODE OF ORDINANCES. NIGHT WORK MAY BE PERFORMED WITH A PERMIT FROM THE METRO NASHVILLE CODES
- DEPARTMENT THE CONTRACTOR SHALL SUBMIT TRAFFIC CONTROL PLANS TO NDOT
- PRIOR TO INSTALLATION OF TRAFFIC CONTROL DEVICES FOR EACH DURING CONSTRUCTION, THE CONTRACTOR SHALL EITHER MAINTAIN APPROPRIATE SIGHT DISTANCE TO ALL TRAFFIC SIGNS OR PROVIDE FOR TEMPORARY SIGNAGE OR FLAGGERS TO GUIDE TRAFFIC
- THROUGH WORK ZONES. THE MINIMUM LANE WIDTH SHOULD BE 10
- THE CONTRACTOR SHALL MAINTAIN ACCESS TO PRIVATE ENTRANCES
- AND DRIVEWAYS AT ALL TIMES.
- ALL TEMPORARY TRAFFIC CONTROL DEVICES SHALL BE RETROREFLECTIVE OR ILLUMINATED DURING NIGHT TIME HOURS. PEDESTRIAN TRAFFIC SHALL BE MAINTAINED AT ALL TIMES WHERE EXISTING SIDEWALKS ARE PRESENT. WHEN NECESSARY, PEDESTRIANS SHALL BE APPROPRIATELY DIRECTED WITH ADVANCED WARNING SIGNS, PLACED AT INTERSECTIONS, TO CROSS TO THE OPPOSITE SIDE OF THE ROADWAY IN ORDER TO PREVENT CONFLICT
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- 12. ACCESS TO BUILDINGS FOR FIREFIGHTING SHALL BE MAINTAINED AT ALL TIMES. EXISTING FIRE APPARATUS ACCESS ROADS (FIRE LANES) SHALL BE KEPT CLEAR OF OBSTRUCTIONS.

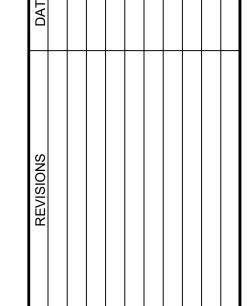

DESIGNED BY: DRAWN BY: CHECKED BY: 03-13-2024


015071080

KIMLEY-HORN PROJECT NO.

TRAFFIC CONTROL PLAN (NIGHT)


SHEET NUMBER TC1-01

CURB RAMP OPTION FROM TDOT STANDARD DETAIL T-WZ-55

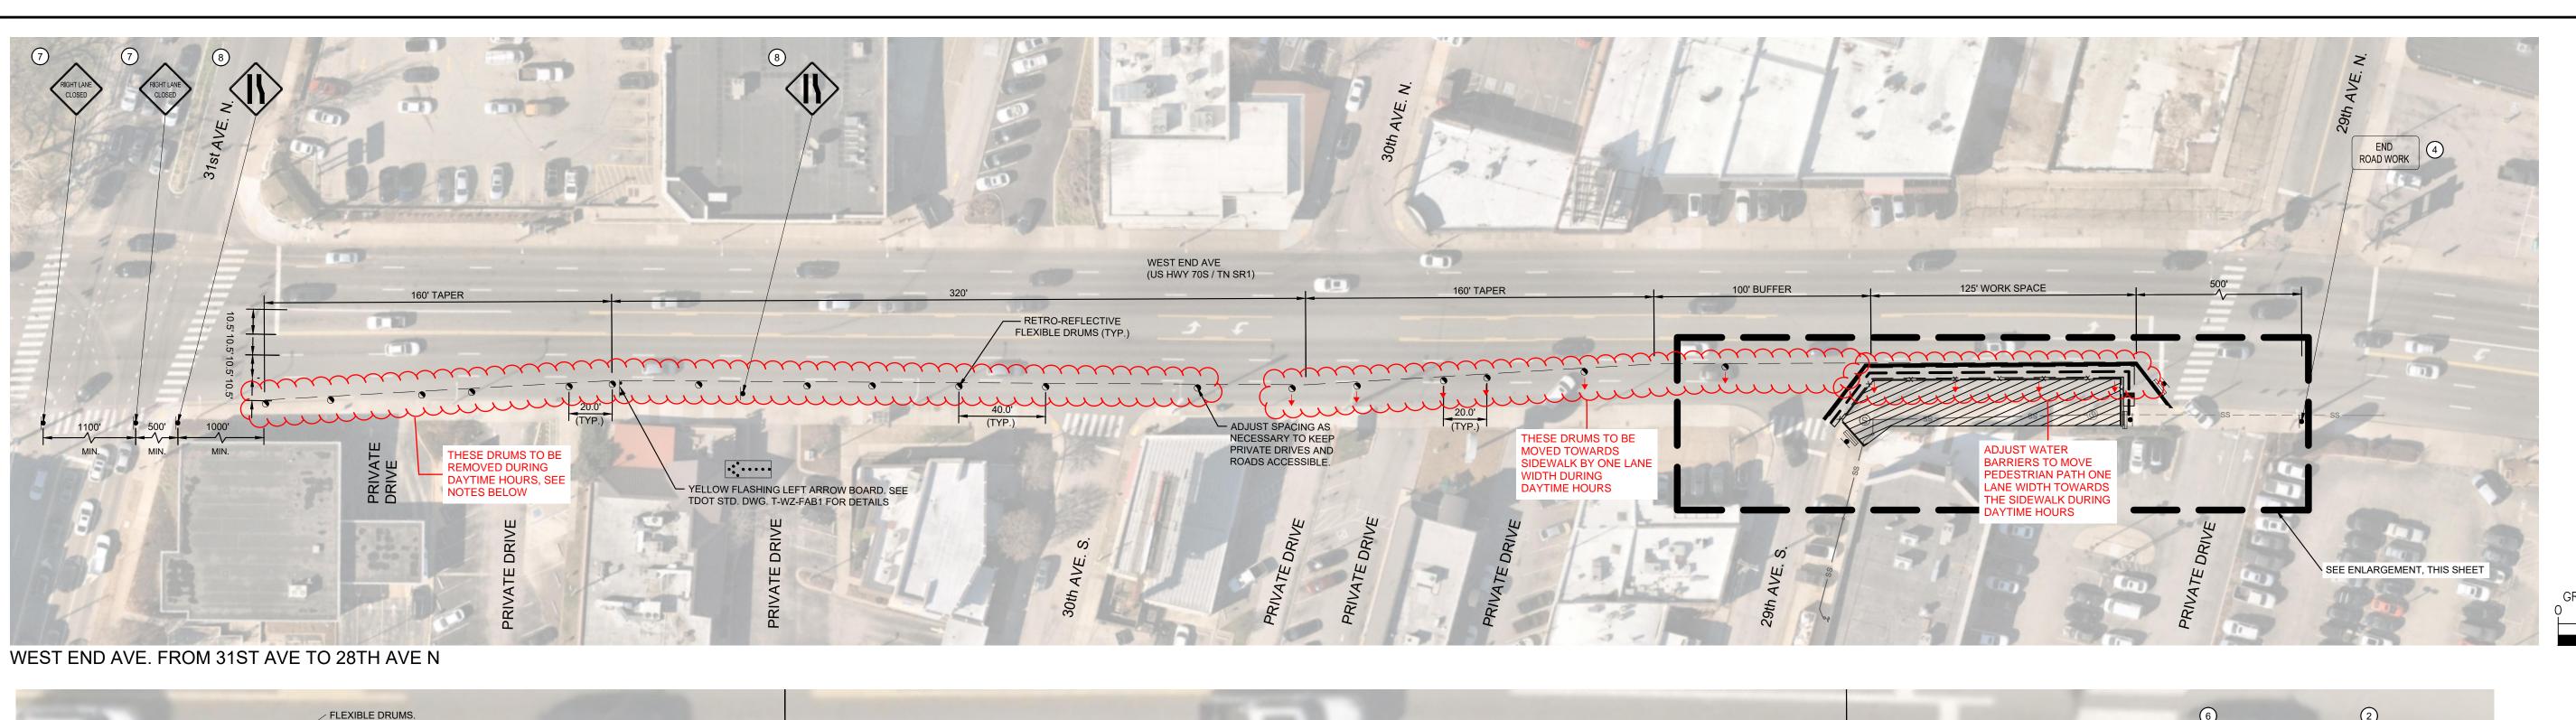




GRAPHIC SCALE IN FEET

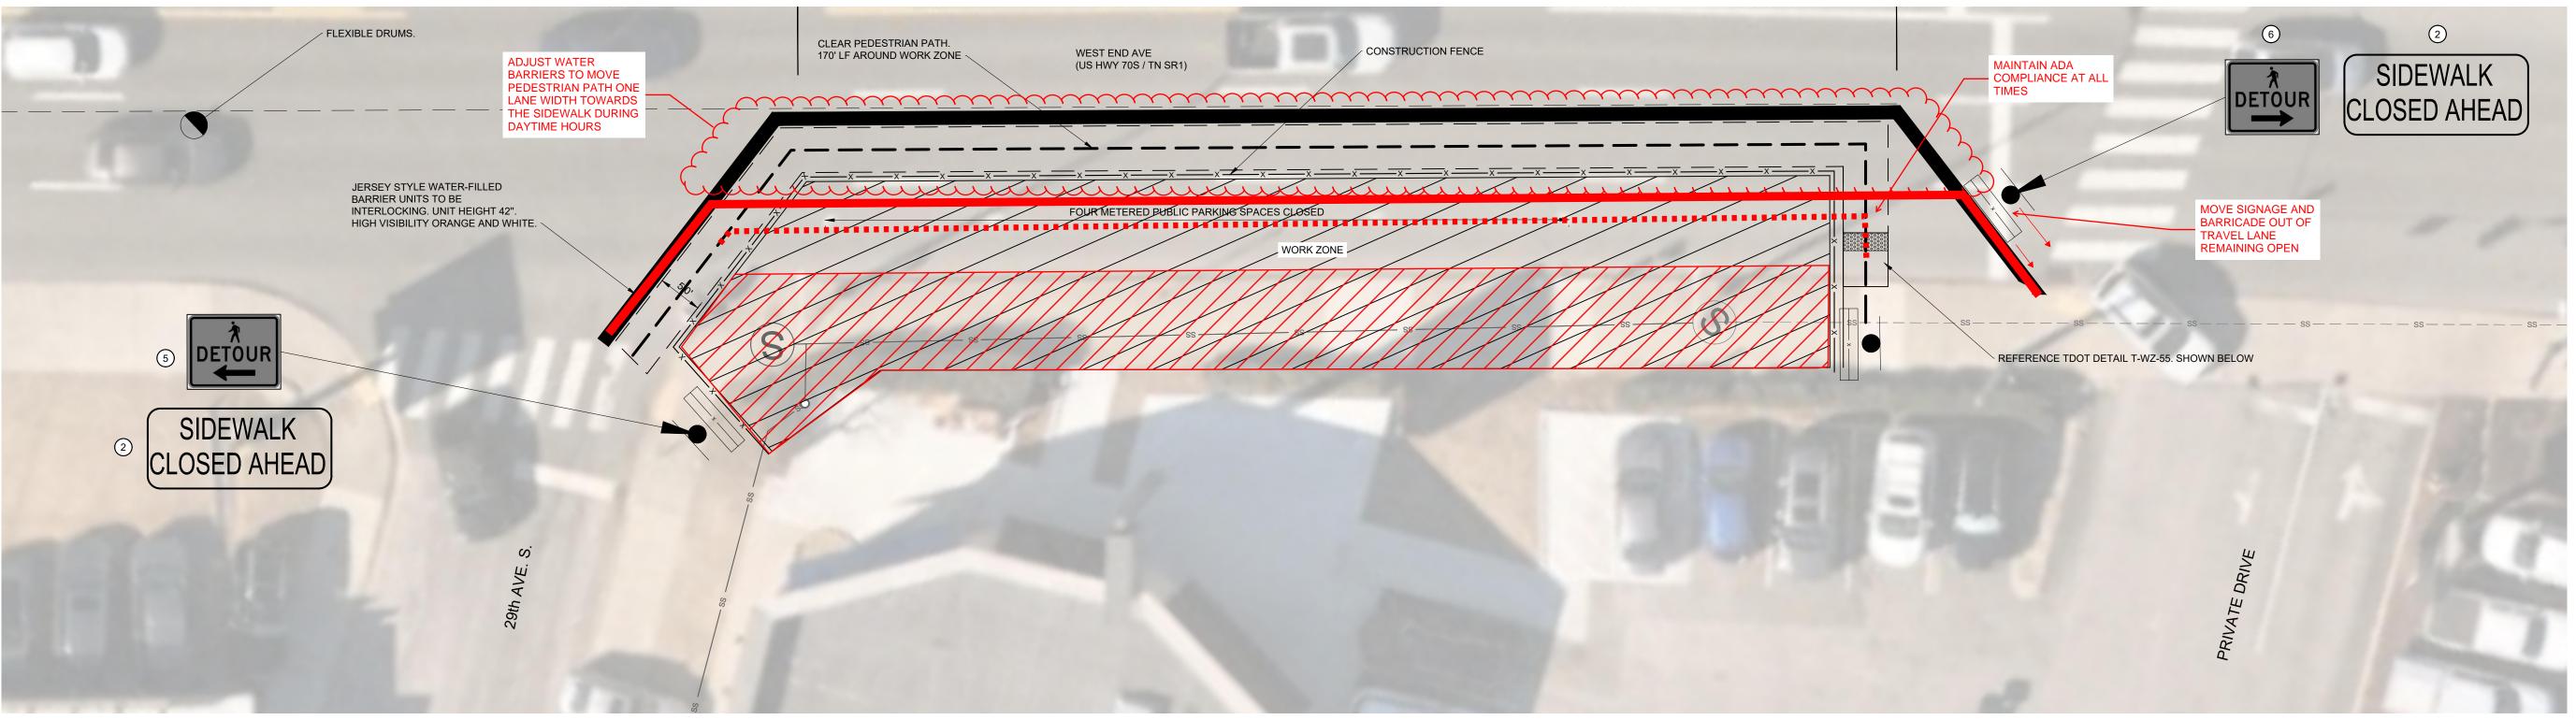




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DESIGNED BY: DRAWN BY: CHECKED BY: 03-13-2024 KIMLEY-HORN PROJECT NO. 015071080

> TRAFFIC CONTROL PLAN (DAY)

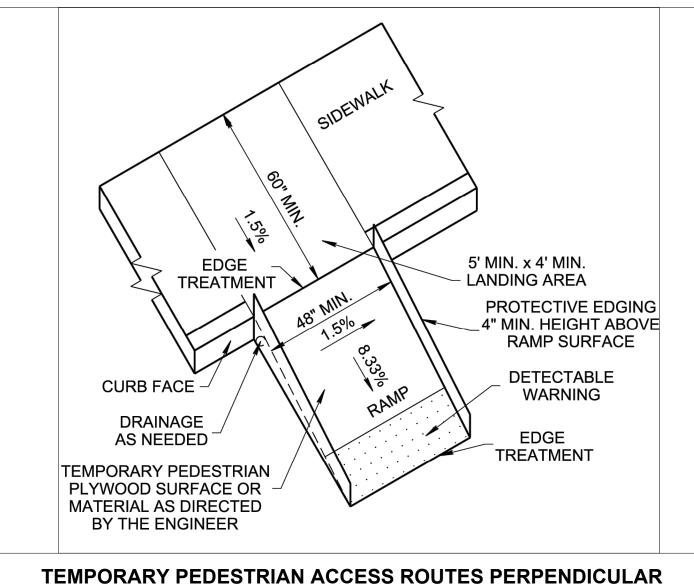SHEET NUMBER TC1-01

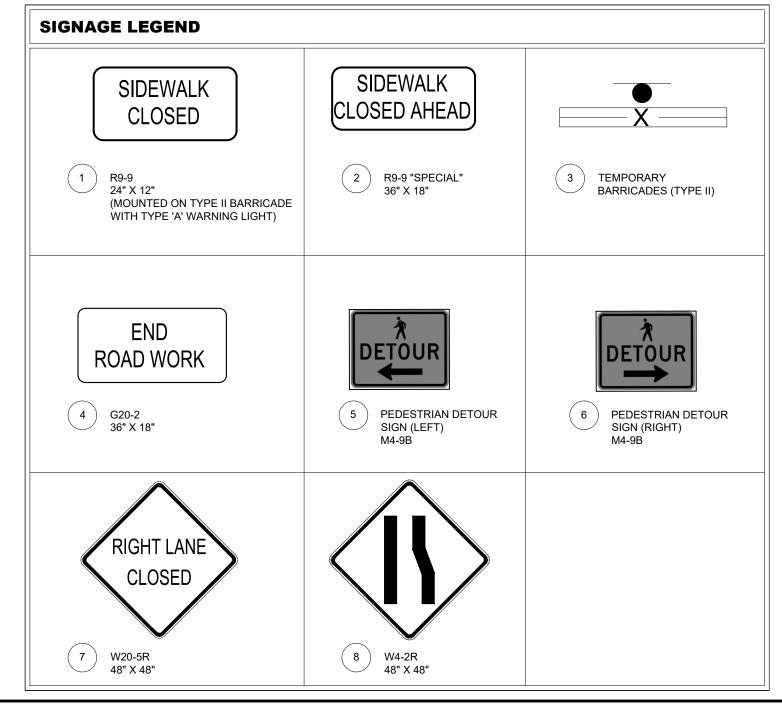CURB RAMP OPTION FROM TDOT STANDARD DETAIL T-WZ-55

550 545 540 8" PVC SDR-35 @ 1.08% 535 134 LF OF 10" VCP @ 1.71% PROPOSED SERVICE LATERAL INV: 535.49 - EXISTING PUBLIC SANITARY MAIN 530 -0+25 0+00 1+00 1+25 SANITARY SEWER PROFILE 1" = 20' H 1" = 2' V

WEST END AVE

(US HWY 70S / TN SR1)

PROPOSED SANITARY MANHOLE (PUBLIC)

STA: 1+04.95

(INV OUT: 535.53 8" PVC

RIM: 542.10

W/ ADA-COMPLIANT SLIP-RESISTANT COVER

EXISTING MANHOLE (PUBLIC) STA: 0+00 RIM: 540.14 INV IN: 534.40 8" PVC N43'57'37"E 75.00

UTILITY NOTES

- CONTRACTOR RESPONSIBLE FOR VERIFYING EXISTING ELEVATIONS COMPARED TO THOSE SHOWN ON PLAN PRIOR TO GRADING. NOTIFY OWNER'S REPRESENTATIVE IF DISCREPANCIES ARE FOUND.
- AREAS FOR CONSTRUCTION THAT REQUIRE DE-WATERING FOR EXCAVATION WILL BE DONE AT NO ADDITIONAL COST TO THE
- ALL WATER MATERIALS AND CONSTRUCTION SHALL BE IN COMPLIANCE WITH METRO WATER SERVICES STANDARD
- SPECIFICATIONS, LATEST EDITION. ALL SEWER MATERIALS AND CONSTRUCTION SHALL BE IN COMPLIANCE WITH METRO WATER SERVICES STANDARD
- SPECIFICATIONS, LATEST EDITION. MAINTAIN MINIMUM 10 FEET HORIZONTAL SEPARATION
- BETWEEN WATER & SANITARY SEWER OR 18" VERTICAL SEPARATION AT CROSSING LOCATIONS.
- REFER TO METRO WATER SERVICES STANDARD SPECIFICATIONS FOR PIPE BEDDING REQUIREMENTS. ALL WATER VALVES TO BE LOCATED OUTSIDE OF PAVED
- THE CONTRACTOR SHALL PROVIDE A COMPLETE SET OF AS-BUILT DRAWINGS OF WATER & SANITARY SEWER CONSTRUCTION PRIOR TO THE ACCEPTANCE OF THE PUBLIC


EXISTING UTILITIES NOTE

AREAS WHERE POSSIBLE.

CONTRACTOR SHALL VERIFY LOCATION OF ALL EXISTING UTILITIES AND NOTIFY ENGINEER IMMEDIATELY OF ANY DISCREPANCIES AND/OR CONFLICTS WITH EXISTING OR PROPOSED UTILITIES PRIOR TO PROCEEDING.


MWS PUBLIC UTILITY PLAN NOTES

- ALL WATER AND SEWER CONSTRUCTION SHALL BE IN ACCORDANCE WITH SPECIFICATIONS AND STANDARD DETAILS OF THE METRO WATER SERVICES. THE CONTRACTOR IS RESPONSIBLE FOR REIMBURSING THE METRO WATER
- SERVICES THE COST OF INSPECTION. THE CONTRACTOR IS TO PROVIDE AND MAINTAIN THE CONSTRUCTION IDENTIFICATION SIGN FOR PRIVATE DEVELOPMENT APPROVED. AFTER COMPLETION OF THE SANITARY SEWER, THE DEVELOPER IS
- RESPONSIBLE FOR THE TELEVISING OF THE LINES PRIOR TO FINAL ACCEPTANCE. THE VIDEOTAPING MUST BE COORDINATED WITH THE METRO WATER SERVICES INSPECTION SECTION. ALL COSTS WILL BE BORNE BY THE DEVELOPER.
- ALL CONNECTIONS TO EXISTING MANHOLES SHALL BE BY CORING AND RESILIENT CONNECTOR METHOD.
- REDUCED PRESSURE BACKFLOW PREVENTION DEVICES (RPBP) OR DUAL CHECK VALVE WILL BE REQUIRED ON ALL TEST AND FILL LINES (JUMPER) NEEDED FOR WATER MAIN CONSTRUCTION AND MUST BE APPROVED BY THE METRO WATER SERVICES.
- ALL WATER METERS SHALL BE A MINIMUM OF 24" NOT TO EXCEED A MAXIMUM OF 28" BELOW FINISHED GRADE.
- UPON COMPLETION OF CONSTRUCTION OF WATER AND/OR SEWER, THE ENGINEER SHALL PROVIDE THE DEPARTMENT WITH A COMPLETE SET OF AS-BUILT PLANS IN DIGITAL (DWG AND PDF) FORMAT. ALL DRAWINGS MUST BE COMPLETED AND SUBMITTED PRIOR TO ACCEPTANCE OF THE SEWERS OR
- WATER MAINS INTO THE PUBLIC SYSTEM AND ANY CONNECTIONS BEING MADE. SEWER PLANS SHALL BE SEALED BY A LICENSED PROFESSIONAL ENGINEER AND/OR A REGISTERED LAND SURVEYOR AND SHALL INCLUDE ACTUAL FIELD ANGLES BETWEEN LINES, ALL ACTUAL SERVICE LINES AND TEE LOCATIONS, THE DISTANCE OF THE END OF THE SERVICE LINE TO PROPERTY COMERS AND LINES AND/OR STATION AND OFFSET FROM SEWER CENTERLINE TO END OF SERVICE LINE, THE DEPTH TO THE TOP OF THE END OF THE SERVICE LINE, AND
- SHALL REFLECT ALL ALIGNMENT AND GRADE CHANGES. WATER LINE PLANS SHALL BE SEALED BY A LICENSED PROFESSIONAL ENGINEER AND/OR A REGISTERED LAND SURVEYOR AND SHALL INCLUDE OFFSET DISTANCE FROM THE ROADWAY CENTERLINE, OR PROPERTY LINE RIGHT OF WAY, LINE DEPTH, LOCATIONS OF HYDRANTS, VALVES, REDUCERS, TEES AND PRESSURE REDUCING DEVICES WHERE APPLICABLE.
- PRESSURE REGULATING DEVICES WILL BE REQUIRED ON THE CUSTOMER SIDE OF THE METER WHEN PRESSURES EXCEED 100 PSI. 0. PRESSURE REGULATING DEVICES WILL BE REQUIRED ON THE STREET SIDE OF THE METER WHEN PRESSURES EXCEED 150 PSI.
- . ALL WATER MAINS MUST BE LOCATED WITHIN THE PAVED AREA INCLUDING ALL BLOW-OFF ASSEMBLIES. . ALL LEAD OR GALVANIZED WATER SERVICE LINES ENCOUNTERED WITH THIS
- PROJECT SHALL BE REINSTATED WITH COPPER OF LIKE SIZE FROM THE WATER MAIN TO THE METER BOX. 13. DOMESTIC AND IRRIGATION WATER METERS AND ASSOCIATED
- APPURTENANCES SHALL NOT BE PLACED IN OR UNDER A PAVED OR IMPROVED SURFACE OTHER THAN THE PORTION OF THE SERVICE LOCATED WITHIN THE RIGHT OF WAY.
- SANITARY SEWER TAPS SHALL BE PLACED AT THE LOWEST ADJACENT SEWER MAIN ELEVATION FOR EACH PREMISES AND SHALL NOT BE LOCATED IN OR UNDER A PAVED OR IMPROVED SURFACE OTHER THAN THE PORTION WITHIN THE RIGHT OF WAY.

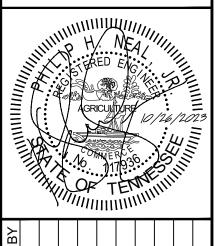

Public Sewer: 23SL0210
Public Water: N/A

METRO WATER SERVICES - NASHVILLE, TN

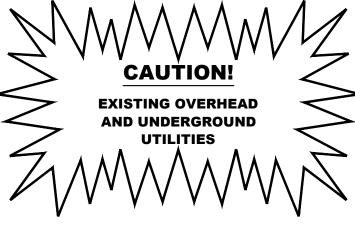

HORIZONTAL DATUM: NAD1983 (CONUS) USFT VERTICAL DATUM: NAVD88 USFT

GRAPHIC SCALE IN FEET O 10 20 4



PUBLIC SEWER PLAN AND PROFILE

DESIGNED BY:

DRAWN BY: CHECKED BY:

> SHEET NUMBER C6-10

 -</t

KIMLEY-HORN PROJECT NO. 015071080

10-26-2023

EXISTING SANITARY MANHOLE (PUBLIC)

EXISTING 10" SEWER MAIN

(VCP @ 1.71% PER SURVEY) —

SHOWN ON GIS

PROPOSED PUBLIC

SEWER EXTENSION -

MWS PROJECT NUMBER NOT

FL10"VCP(NE)=531.5

FL10"VCP(SW)=531.9

